



"VERIFY ALL FIELD CONDITIONS PRIOR TO BID"

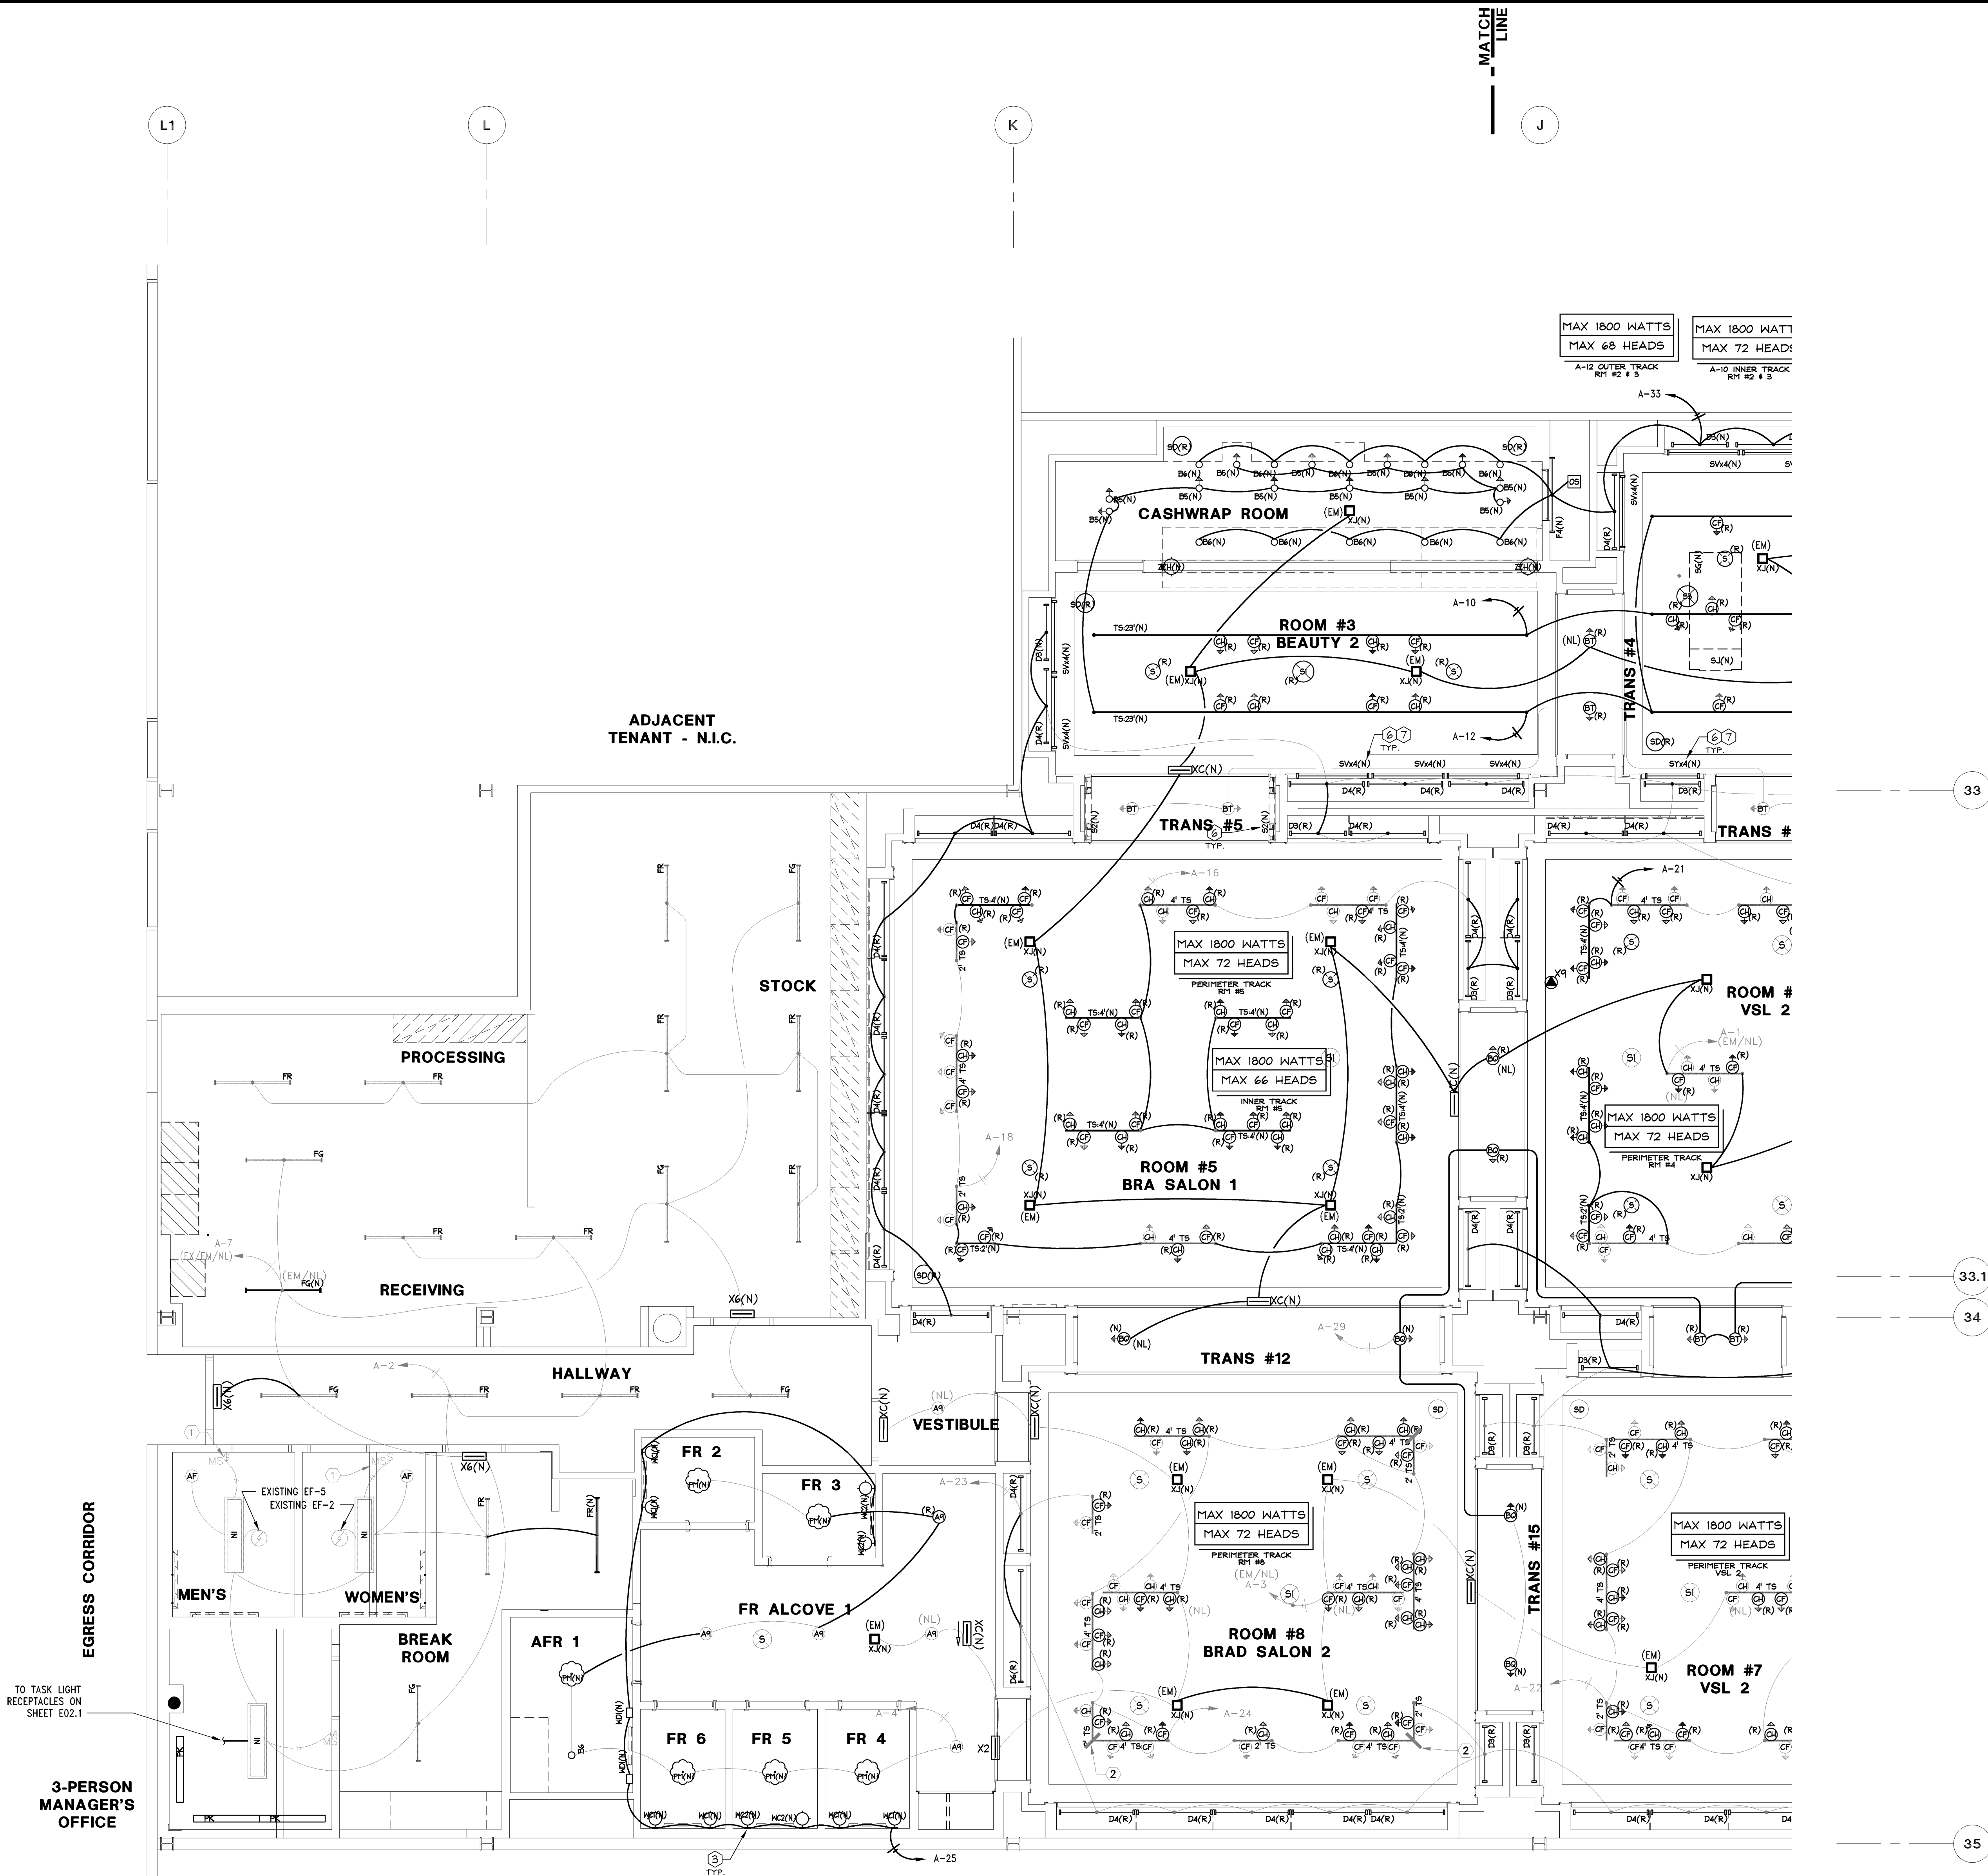

- ELECTRICAL CONTRACTOR SHALL INSTALL OCCUPANCY MOTION SENSOR SWITCH FOR CONTROL OF LIGHTS AS SHOWN. ELECTRICAL CONTRACTOR SHALL SET SWITCH FOR 15 MINUTES. MOUNT AT 44" AFF.
  - BREAK-OFF CIRCUIT.
  - JUNCTION BOX INSTALLED AT THE CENTERLINE OR MOUNTING PLATE OF WALL SCONCE. SEE ARCHITECTURAL DRAWINGS FOR MOUNTING HEIGHTS.
  - LOCATE RF ANTENNA ABOVE CEILING IN ACCESSIBLE LOCATION WITHIN REACH OF ACCESS POINT. MOUNT TO BOTTOM OF STRUCTURE IF POSSIBLE. PROVIDE 1/2" CONDUIT TO RF FOR A GROUP OF (4) RF ANTENNAS.
  - EXISTING JUNCTION BOX, TOGGLE DISCONNECT SWITCH IN NON-VISIBLE LOCATION, FINAL CONNECTION FOR 120 VOLT SIGN AND CONDUIT PER DETAIL. SIGN IS FURNISHED WITH INTERNAL GROUND FAULT PROTECTION BY SIGN MANUFACTURER PER N.E.C. ARTICLE 600-236. VERIFY EXACT LOCATION OF JUNCTION BOX WITH SIGN MANUFACTURER. (REUSE EXISTING JUNCTION BOX AND CONDUIT INTO SPACE IF ALREADY INSTALLED. VERIFY IN FIELD EXACT LOCATION ON CANOPY).
- NOTE:  
THE CIRCUIT FOR SIGNAGE MUST BE A DEDICATED ISOLATED 3-LINE CIRCUIT CONSISTING OF HOT, NEUTRAL, AND GROUND WIRES LEADING DIRECTLY TO THE PANEL.
- REFER TO SHEET E02.1 AND E02.2 FOR POWER REQUIREMENTS.
  - LIGHT FIXTURES TO BE INSTALLED IN MILLWORK FIXTURE, NOT IN CEILING. VERIFY WITH LS&C.
  - LIGHT FIXTURES ARE MOUNTED TO A MOVABLE ACCESS PANEL. INSTALL WITH ENOUGH SLACK TO ALLOW THE PANEL TO FULLY OPEN AND NOT PUT EXCESS TENSION ON THE WIRE. REFER TO ARCHITECTURAL DRAWINGS FOR MORE INFORMATION.

- NEW CKT  
EXISTING CKT
- NOTE:  
REFER TO SHEET E04.1 AND E08.1 FOR ELECTRICAL LIGHTING SCHEDULE AND LIGHT DESCRIPTIONS.
- NOTE:  
REFER TO SHEET E05.1 FOR PANEL SCHEDULE AND LIGHTING ZONE DESIGNATIONS.
- NOTE:  
LENGTH OF FLEXIBLE METAL CONDUIT, MC TYPE CABLE, OR AC90(CANADA) IS NOT TO EXCEED 6'-0".
- NOTE:  
ELECTRICAL CONTRACTOR SHALL REFER TO ARCHITECTURAL SHEETS FOR MOUNTING HEIGHTS AND INSTALLATION DETAILS FOR SUSPENDED LIGHTING IN NON-SALES AREA.
- NOTE:  
GENERAL CONTRACTOR SHALL VERIFY CEILING FIRE RATING WITH ARCHITECT, AND BOX OR TENT ALL RECESSED LIGHT FIXTURES, IF REQUIRED, TO MAINTAIN CEILING FIRE RATING.

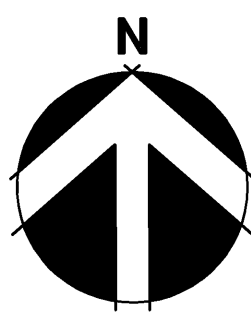

1/4" = 1'-0"

A

M-Engineering  
750 Brookside Blvd.  
Westerville, Ohio 43081  
phone: 614.839.4639  
fax: 614.839.2222  
www.mengineering.us.com

Limited brands

LIMITED STORE PLANNING, INC.  
d/b/a STORE DESIGN & CONSTRUCTION  
Three Limited Parkway Columbus, Ohio 43230  
Telephone: 614.415.7000 Fax: 614.415.7349

PROJECT INFORMATION: 010500133

VICTORIA'S SECRET  
QUAIL SPRINGS MALL  
SPACE NO. 119  
2501 WEST MEMORIAL RD.  
OKLAHOMA CITY, OK 73134

REVISIONS:

REVISIONS:	DATE:
REQUIRED BY:	

ELITE CONSTRUCTION GROUP  
LAKE JACKSON, TX  
PHONE: 979.288.0715  
NOTE: THESE PRINTS HAVE BEEN REDUCED BY 50 PERCENT SCALE.  
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DATE ISSUED: 05.30.2014  
DESIGNED BY: ASB  
DRAWN BY: ASB  
CHECKED BY: DFG

ELECTRICAL LIGHTING PLAN

DRAWING NUMBER: E03.1